

YA4795 TEANAWAY

8560 ELK SPRINGS RD ELLENSBURG, WA 98926



Kittitas County CDS

PROJECT CONTACT LIST

APPLICANT: PROPERTY OWNER: AT&T MOBILITY STATE OF WASHINGTON (DNR) RTC BUILDING 3 416 SID SNYDER AVE SW OLYMPIA, WA 98501 CONTACT: CHAD UNLAND 16221 NE 72ND WAY REDMOND, WA 98052 PHONE: (509) 926-0935 PROJECT CONSULTANT:

PROJECT MANAGER: VELOCITEL, INC.

CONTACT: CHRIS FORSBERG PHONE: (503) 636-2500 x220 EMAIL: cforsberg@velocitel.com

SITE ACQUISITION & PERIMITTING:

VELOCITEL, INC CONTACT: DIEGO HERNANDEZ PHONE: (503) 313-0150 EMAIL: dhemandez@velocitel.com

CONSTRUCTION MANAGER:

VELOCITEL, INC. CONTACT: CRAIG ASHBAUGH PHONE: (971) 777-4466 EMAIL: cashbaugh@velocitel.com

DRAWING INDEX

DWG NO.	DESCRIPTION
T-1.0	TITLE SHEET
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A-1.0	BOUNDARY PLAN
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-2.0	ENLARGED SITE PLAN
-3.0	ELEVATIONS



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DATE:	12-28-18
DRAWN BY:	KTL
CHECKED BY:	RBH

REV	DATE	DESCRIPTION	BY
1	12-28-18	PRELIMINARY ZONING	KTL
2	1-8-19	FINAL ZONING	ENS
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APPROVAL STAMP

T18-816

TEANAWAY

8560 ELK SPRINGS RD ELLENSBURG, WA 98926

> SHEET TITLE TITLE SHEET


SHEET NUMBER T-1.0

PROPRIETARY INFORMATION

THE INFORMATION CONTAINED IN THIS SET OF CONSTRUCTION DOCUMENTS IS PROPRIETARY BY NATURE. ANY USE OR DISCLOSURE OTHER THAN THAT WHICH RELATES TO AT&T MOBILITY SERVICES IS STRICTLY



VICINITY MAP

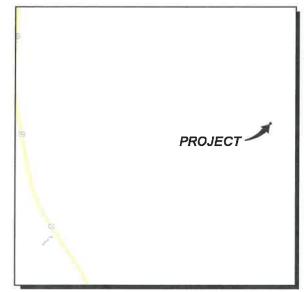

GENERAL LOCATION MAP

DRIVING DIRECTIONS

- HEAD SOUTHEAST ON NE 72ND WAY TOWARD 164TH AVE NE
- TURN RIGHT ONTO 164TH AVE NE TURN RIGHT ONTO BEAR CREEK PKWY
- USE THE LEFT 2 LANES TO TURN LEFT ONTO LEARY WAY USE THE MIDDLE 2 LANES TO TAKE THE RAMP ONTO WA-520 W
- MERGE ONTO WA-520 W
- TAKE THE INTERSTATE 405 S EXIT TOWARD RENTON
- USE THE RIGHT 3 LANES TO TAKE EXIT 11 TO MERGE ONTO I-90 E TOWARD SPOKANE
- TAKE EXIT 85 FOR WA-970 N TOWARD WENATCHEE
- TURN LEFT ONTO WA-10/WA-970
- TURN RIGHT TO STAY ON WA-10/WA-970
- CONTINUE TO FOLLOW WA-970
- TURN RIGHT ONTO US-97 S TURN LEFT ONTO UNNAMED RD
- TURN LEFT ONTO UNNAMED RD DESTINATION WILL BE ON THE LEFT

-	CONSULTANT GROUP SIGN OFF	DATE	SIGNATURE	AT&T SIGN OFF	DATE	SIGNATURE
200	CONSTRUCTION COORDINATOR			COMPLIANCE		
Veidi	LANDLORD'S REPRESENTATIVE			CONSTRUCTION MANAGER		
	PROJECT MANAGER			DEPLOYMENT MANAGER		
	SITE ACQUISITION			E-911 ENGINEER		Y N INITIAL:
20102	ZONING			INTERCONNECT		
	POWER/TELCO COORDINATOR			OPERATIONS		
GIBC				RF ENGINEER		
	REVIEWERS SHALL CLE	ARLY PLAC	E INITIALS ADJACENT TO	RF ENGINEER MANAGER		
wirig:	EACH REDLINE NOTE AS	DRAWING	S ARE BEING REVIEWED	SITE ACQUISITION MANAGER		

APPROVAL / SIGN OFF OF FINAL ZONING DRAWINGS

PROJECT INFORMATION

CODE INFORMATION:

VELOCITEL, INC.

LDC INC

4004 KRUSE WAY PLACE, STE 220

CONTACT: RICHARD B. HALL, AIA

LAKE OSWEGO, OR 97035

PROJECT ARCHITECT:

PHONE: (503) 636-2500

PHONE: (425) 806-1869

EMAIL: rhall@ldccorp.com

ZONING CLASSIFICATION: FR (FOREST & RANGE) BUILDING CODE: IBC 2015 CONSTRUCTION TYPE: OCCUPANCY:

KITTITAS COUNTY JURISDICTION: PROPOSED BUILDING USE: UNMANNED TELECOM

SITE LOCATION (NAD83):

LATITUDE: LONGITUDE: (47.183124° N) 47° 10' 59.25" N 120° 41' 37.13" W (120.693646° W) TOP OF STRUCTURE: BASE OF STRUCTURE: 3497.50' AMSL 150.0' AGL 3347.50' AMSL

PROJECT LEASE AREA:

NEW IMPERVIOUS AREA:

GENERAL INFORMATION:

1. PARKING REQUIREMENTS ARE UNCHANGED.

PARCEL NUMBER:

AREA OF PARCEL:

TRAFFIC IS UNAFFECTED.

3. SIGNAGE IS PROPOSED.

LEGAL DESCRIPTION

SEE SV-1.1 FOR FULL LEGAL DESCRIPTION

UTILITY COMPANIES

POWER: SELF-GENERATED (ON SITE)

TELEPHONE: MICROWAVE (ON SITE)

PROJECT DESCRIPTION

AT&T MOBILITY PROPOSES THE INSTALLATION OF A NEW 150.0' SELF SUPPORT TOWER, A PRE-FABRICATED CMU BLOCK SHELTER, AN ADJACENT GENERATOR W/ PLATFORM, AND AN AUGMENTED ALTERNATE POWER SOURCE WITHIN A PROPOSED UNMANNED TELECOMMUNICATIONS FACILITY




PRELIMINARY

15.17E ±

YA4795 TEANAWAY

WEST 1/2 OF SEC. 34, T. 20 N., R. 17 E, W.M. KITTITAS COUNTY, WASHINGTON

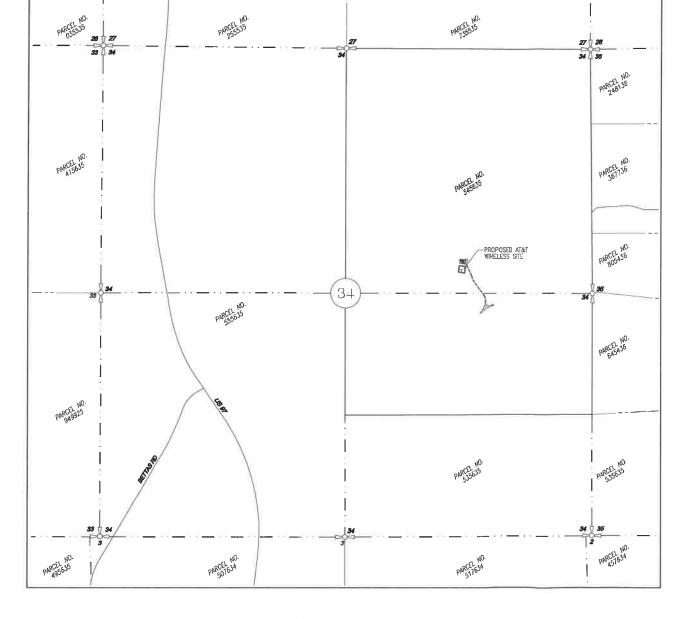



PROJECT INFORMATION

PROJECT LEASE AREA: 4,900 SF

3347.5'

SURVEYOR'S NOTES

1. THIS SUPEY WAS COMPLETED WITHOUT THE BENEFIT OF A TITLE REPORT.

2. LATITUDE AND LONGITUDE TAKEN AT EXISTING TOWER LOCATION.

3. MAGNETIC NORTH DELINATION OF APPROXIMATELY 15.77 E FOR THE DATE OF 11-28-18, COMPUTED BY USING THE MAGNETIC FIELD CALCULATION ON THE MIDDA NATIONAL SCIPPHYSICAL DATA CENTER WEBSITE AND BOSS NOT ACCOUNT FOR ANY LOCAL VARATION OF ANOMALY.

4. II IS OUR POSITION THAT, DUE TO HISTORICAL PROTOCOL, INDUSTRY STANDARDS, AND LOCK OF CONTRARY EVIDENCE, THE DEED WAS INTENDED TO FOLLOW TRUE GEODETIC BEARING. BOUNDARY REPRESENTS DEED LOCATION.

BOUNDARY DISCLAIMER
THIS SUPPLY MAS BEEN PREPARED FOR THE EXCLUSIVE USE OF PARTIES WHOSE
MANES APPEAR PREPARED HORY, AND DOES MOT EXTEND TO ANY UNMANED THIRD
PARTIES WITHOUT EXPRESS RECERTIFICATION BY THE LAND SURVEYOR.

THIS COES NOT PURPORT TO BE A BOUNDARY SURVEY, DEED LINES SHOWN HAVE NOT BEEN FIELD VERIFIED.

UTILITY NOTE

THE LOZAINE OF DISTING UTILITY FACILITIES HAS NOT BEEN RESURCHED. SUPPLYOR DOES NOT CLUBANITEE THAT ALL UTILITIES ARE SHOWN OF THEIR DOCATIONS. IT IS THE RESPONSIBILITIES OF THE CONTRACTION AND DEVELOPER TO CONTRACT THE "ONE—CALL STRIVE" AND DAYN OTHER MOVIDED ACROSS TO LOCATE ALL UTILITIES PRIOR TO CONSTRUCTION. REMOVAL, RELOCATION AND/ OR REPLACEMENT IS THE RESPONSIBILITY OF THE CONTRACTOR LESUROYUGH ASSUMES NO RESPONSIBILITY FOR THE CONTRACTOR SUCH UNDERSON OF SUCH UNDERSOND UTILITIES, MOR FOR THE DUSTENCE OF BURRED OBJECTS WHICH ARE NOT SHOWN ON THE MAP.

BASIS OF ELEVATION

ELEVATION ESTABLISHED FROM GPS DERIVED ORTHOMETRIC HEIGHTS,
APPLYING GEOID 12B SEPARATIONS USING YEARN RIX NETWORK
SOLUTION, ACCURACY MEDTS OF EXCELEDS IN STANDARDS AS
DEFINED ON THE FAA ASAC INFORMATION SHEET 91:003.

BASIS OF BEARING

SURVEY DATE NOVEMBER 28, 2018

SURVEY REFERENCES

R1 RECORD OF SURVEY BOOK 22, PAGE 104, AF NO. 199610240028, FILLED IN KITITIAS, COUNTY, WA

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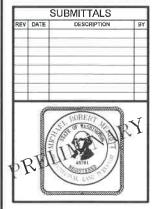
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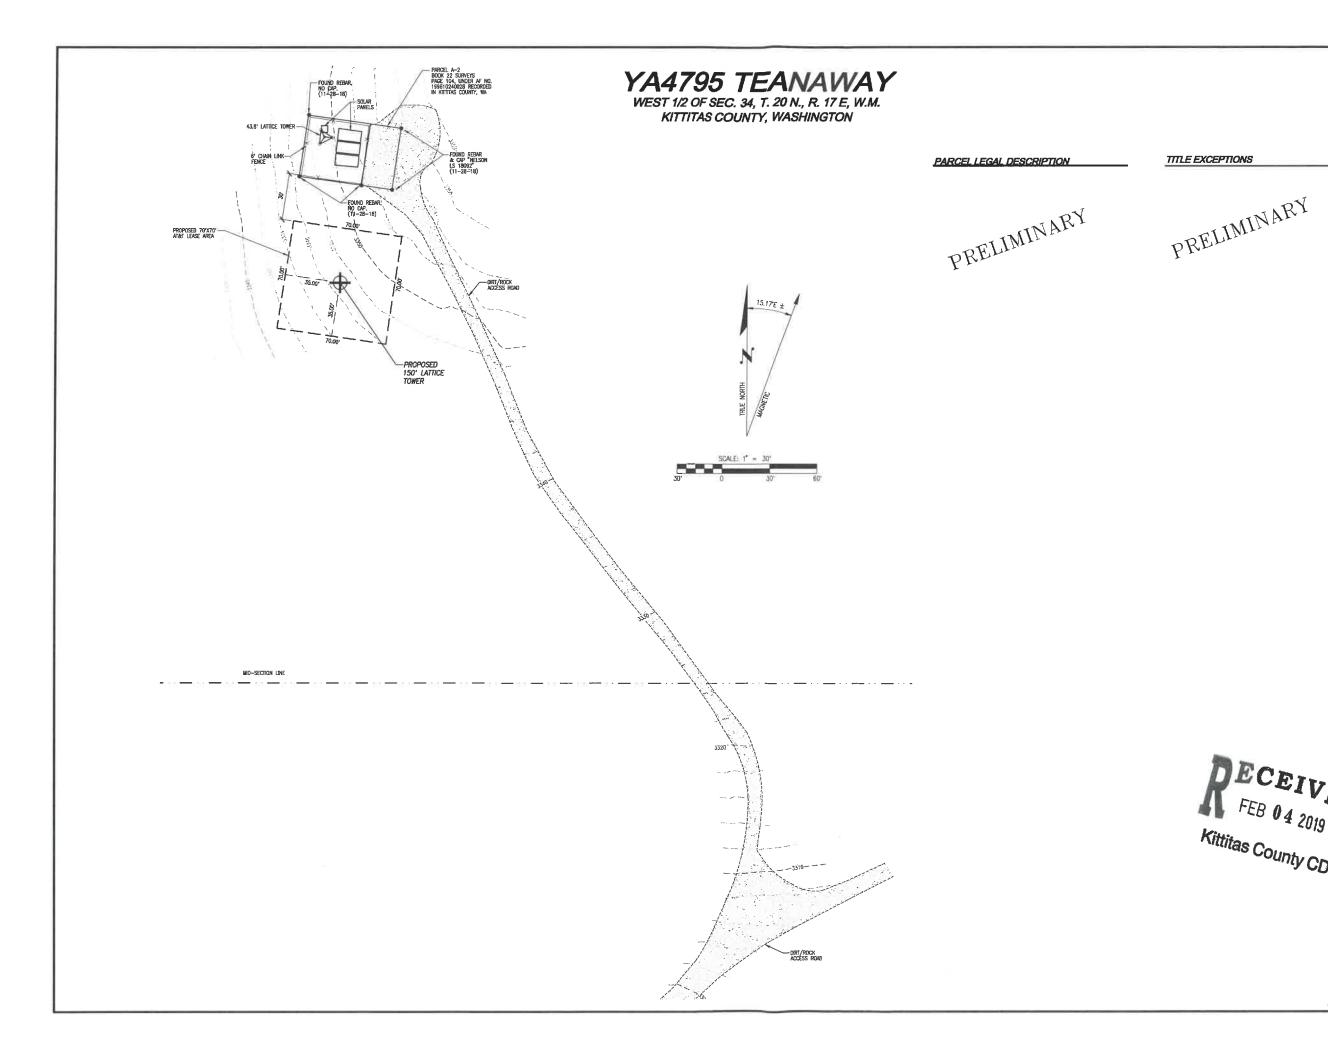
SITE YA4795 8560 ELK SPRINGS RD ELLENSBURG, WA 98926

> SHEET TITLE CIVIL SURVEY

SHEET NUMBER SV-1.0

BOUNDARY DETAIL

LEGEND BOUNDARY LINE SECTION CORNER FOUND SECTION LINE EASEMENT LINE RIGHT-OF-WAY LINE SECTION CORNER CALC'D - RIGHT-OF-WAY CENTERLINE SECTION OTR CORNER FOUND 100 ADJACENT PROPERTY LINE SECTION QTR CORNER CALCED ---- POWER PAINT MARK





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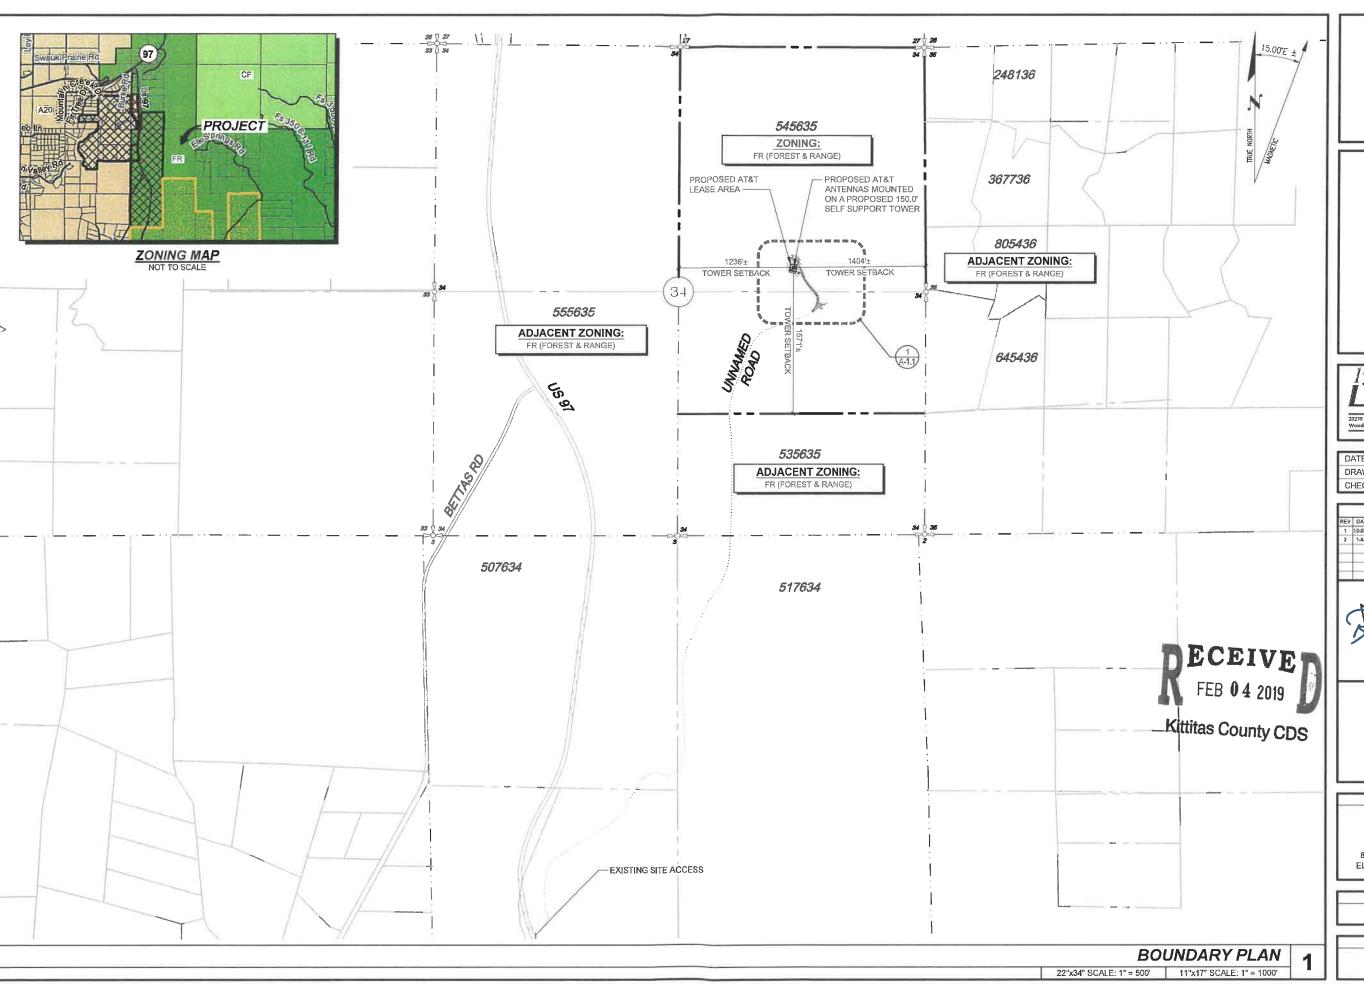
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SHEET TITLE CIVIL SURVEY

SHEET NUMBER **SV-1.1**

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SUBMITTALS 12-28-18 PRELIMINARY ZONING


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SITE T18-816 TEANAWAY 8560 ELK SPRINGS RD ELLENSBURG, WA 98926

SHEET TITLE BOUNDARY PLAN

SHEET NUMBER

A-1.0

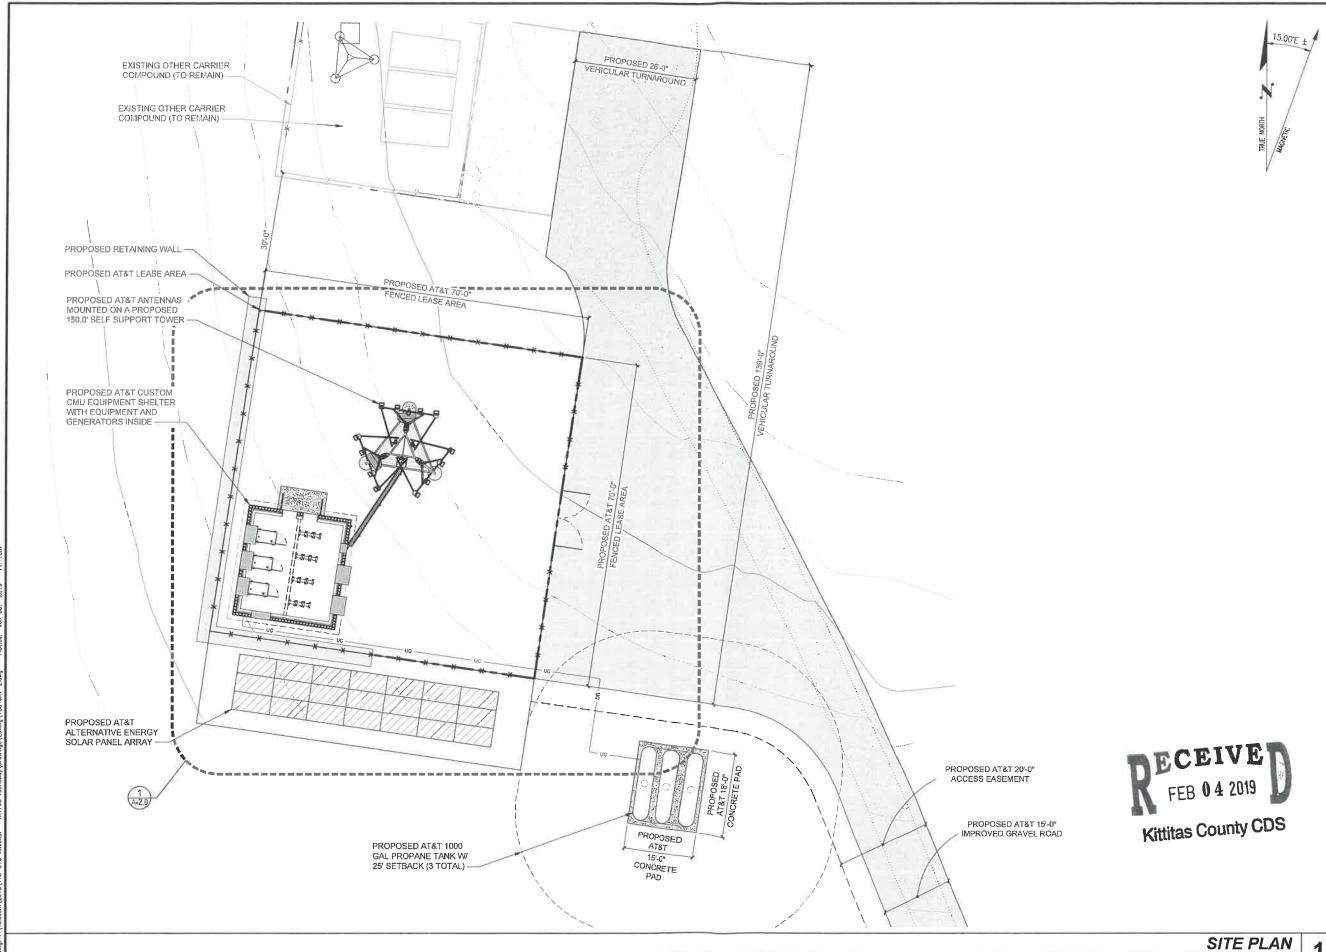

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15th 4 N (N) V
LDC | Surveying Engineering Planning
20210 142nd Avenue NE Woodinville, WA 98072 | Fr. 425.482.2893

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1	12-28-18	PRELIMINARY ZONING	KTL
2	1-8-19	FINAL ZONING	ENS



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SITE

T18-816 TEANAWAY

8560 ELK SPRINGS RD ELLENSBURG, WA 98926

> SHEET TITLE SITE PLAN

SHEET NUMBER

22"x34" SCALE: 1" = 10'

11"x17" SCALE: 1" = 20'

A-1.2



CONSTRUCTION PLAN KEYED NOTES

- 1 PROPOSED AT&T LEASE AREA.
- 2 PROPOSED AT&T CUSTOM CMU EQUIPMENT SHELTER.
- 3 PROPOSED AT&T EQUIPMENT ROOM WITHIN PROPOSED SHELTER.
- PROPOSED 150.0' SELF SUPPORT TOWER. ENGINEERING BY OTHERS. SEE SITE NOTE 3.
- 5 PROPOSED AT&T CONCRETE PAD.
- PROPOSED AT&T TRIPLE SECTOR FRAME ANTENNA MOUNT KIT (3 TOTAL).
- 7 PROPOSED AT&T CABLE LADDER.
- SITE TO BE FILLED WITH 6" OF 3/4"Ø CRUSHED ROCK W/ WEED BARRIER ON 95% COMPACTED FILL.
- PROPOSED 6'-0" TALL CHAIN LINK FENCE W/ BARBED WIRE AND PRIVACY SLATS.
- PROPOSED CHAIN LINK DOUBLE SWING GATE
 W/ PRIVACY SLATS AND LOCKING MECHANISM.
 AT&T SIGNAGE MOUNTED TO GATE.
- 11> PROPOSED AT&T MICROWAVE W/ MOUNT, TYP (2 TOTAL).
- PROPOSED AT&T PANEL ANTENNA (TYP 4 PER SECTOR, 12 TOTAL).
- PROPOSED DC POWER CABLE TO SQUID (2 TOTAL).
- PROPOSED AT&T 10'-0" TALL PEDESTAL MOUNTED ICE BRIDGE W/ 8'-0" CLEAR BELOW COAX SUPPORT.
- 18 PROPOSED AT&T ALTERNATIVE ENERGY SOLAR PANEL ARRAY.
- PROPOSED AT&T 1000 GAL PROPANE TANK W/ 25' SETBACK (3 TOTAL).
- PROPOSED AT&T GPS/ E-911 DOWNLINK ANTENNAS MOUNTED TO SHELTER (2 TOTAL).
- 21) PROPOSED UNDERGROUND GAS ROUTING.
- PROPOSED AT&T PROPANE GENERATOR (3. FEB 04 20

Kittitas County Ct

- PROPOSED AT&T RAYCAP DC SURGE SUPPRESSION (SQUID) MOUNTED NEAR ANTENNAS (1 TOTAL).
- PROPOSED AT&T RRH UNIT MOUNTED NEAR ANTENNAS (TYP 4 PER SECTOR, 12 TOTAL).

SITE NOTES

- CONTRACTOR TO FIELD VERIFY SITE CONDITIONS DEPICTED IN
 THESE DRAWING AND NOTIFY THE ENGINEER OF RECORDED OF ANY
 DISCREPANCIES RELATED TO THE PROPOSED SCOPE OF WORK.
- 2. VERIFY ANTENNA MODEL, RAD CENTER & AZIMUTHS WITH LOCKDOWN SET RF SITE BUILD FORM.
- 3. ANALYSIS OF TOWER & FOUNDATION SHALL BE PERFORMED BY OTHERS & STAMPED BY A LICENSED STRUCTURAL ENGINEER.
- 4. CROSS SECTOR REDUNDANCY BETWEEN THE PROPOSED RRH UNITS SHALL BE UTILIZED PER AT&T STANDARDS.
- 5. PROPOSED ANTENNAS, EQUIPMENT AND MOUNTING HARDWARE NEAR ANTENNA LEVEL SHALL BE PAINTED TO MATCH EXISTING.

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П	DATE:	12-28-18
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1	12-28-18	PRELIMINARY ZONING	KTL		
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SITE

T18-816


TEANAWAY 8560 ELK SPRINGS RD

ELLENSBURG, WA 98926

SHEET TITLE ENLARGED SITE PLAN

SHEET NUMBER

A-2.0

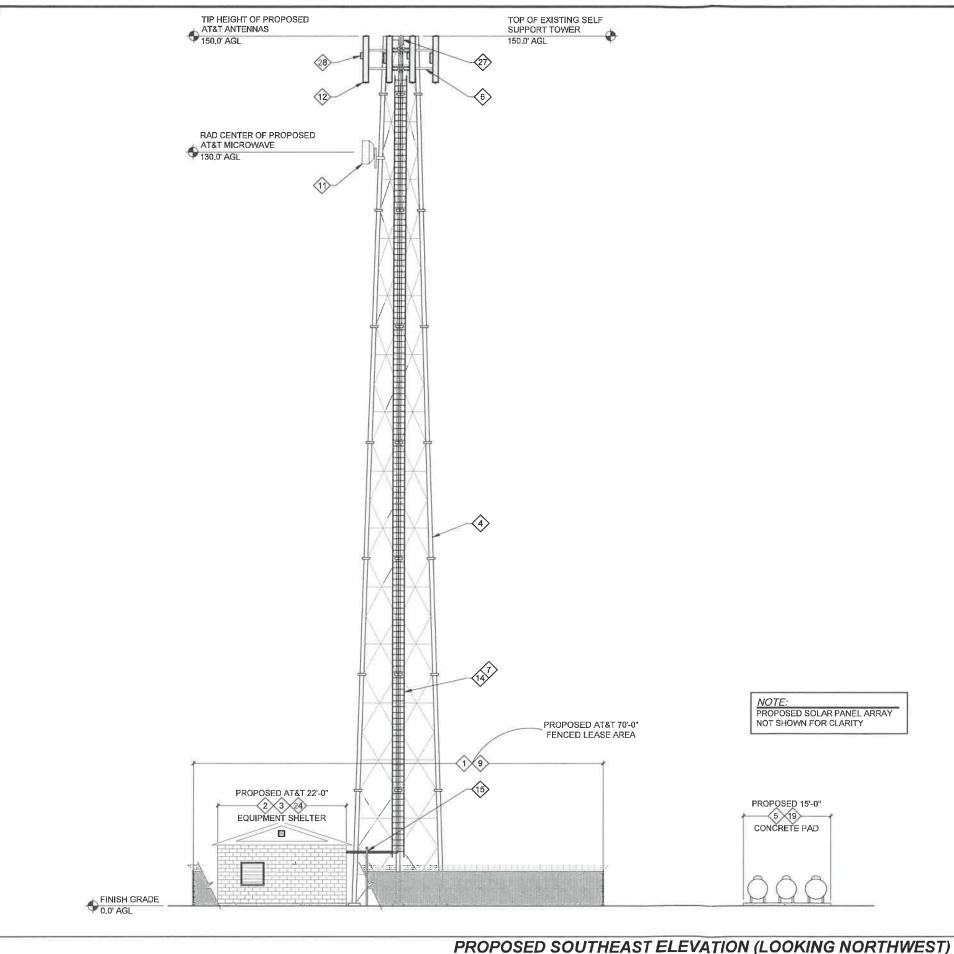

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PROPOSED AT&T 1000 GAL PROPANE TANK W/ 25' SETBACK (3 TOTAL).

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24 PROPOSED AT&T PROPANE GENERATOR (3 TOTAL).

PROPOSED AT&T RAYCAP DC SURGE SUPPRESSION (SQUID) MOUNTED NEAR ANTENNAS (1 TOTAL).

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> SHEET TITLE ELEVATIONS

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